

567 Bishop Gate Lane Jacksonville, Florida 32204 Tel 904.384.7020 www.swca.com

April 15, 2025

Mr. John Fellows Project Manager U.S. Army Corps of Engineers, Jacksonville District 701 San Marco Boulevard Jacksonville Florida 32207

Re: SAJ-2019-00480

Dear Mr. Fellows:

SWCA Environmental Consultants has received your letter dated March 17, 2025, in reference to our permit application submitted on January 2, 2025. The permit application number assigned is SAJ-2019-00480. The questions listed in your Request for Additional Information (RAI) are shown below in bold and are followed by our responses in italicized text.

1. Figures and Exhibits:

Please provide the following three items for the public notice drawings:

a. a Vicinity/Location map. The Vicinity/Location Map should provide sufficient detail to allow one to find the subject parcel. Please include the names of major streets and roadways, the Section/Township/Range of the project, the Latitude and Longitude of the project, and street address of the project (if available).

Figure 1 – Location Map, as submitted in the permit application (page 46 of 391) to the U.S. Army Corps of Engineers (USACE) on January 2, 2025, is attached below.

b. a figure that clearly shows the proposed site plan and adjacent site features, including specific locations and dimensions of existing and proposed structures or activities. Show the total plan of development including existing and future phases.

Figure 10 – Mine Plan Map, as submitted in the permit application (page 54 of 391) to the USACE on January 2, 2025, is attached below.

c. a drawing that shows the cross-sectional (elevation) view of the project and impact areas to indicate the relationship to the affected waters.

Figures 11A – 11R – Wetland Impact Cross-Sections, as submitted in the permit application (page 80 - 97 of 391) to the USACE on January 2, 2025, are attached below.

For your convenience, Figure 11 – Wetland Impact Map, which illustrates the attached Wetland Impact Cross-Section locations, as submitted in the permit application (page 55 of 391) to the USACE on January 2, 2025, is also attached below.

2/20

The Corps may ask you to provide additional drawings, figures, etc. for the review, however we currently limit public notice attachments to these three items. The figures and exhibits should be scaled and show a north arrow on the plan view. Where necessary, please provide a legend on the figure, rather than a separate page.

2. Project Description:

Please provide the following:

a. the total acreage of impacts to all aquatic resources for the overall project,

The overall project will impact 740.45 acres of aquatic resources (692.14 acres of which are considered jurisdictional), as defined in the Environmental Support Document (ESD) and Tables 2 and 3, as submitted in the permit application (page 61 and 62 of 391) to the USACE on January 2, 2025.

Table 2 – Wetlands and Surface Waters and Table 3– Jurisdictional Wetlands Impact Summary are attached below.

plus:

i. a breakdown of that total acreage by aquatic resource type (wetlands – forested and herbaceous, natural, or man-altered surface waters, upland-cut surface waters)

Please see RAI 1 – Table 1 – Total Impact Acreage, attached below.

ii. the acreage of completed impacts to all aquatic resources

Currently, an approximate total of 314.59 acres of aquatic resources impacts have been completed as of March 2025.

iii. a breakdown of that completed acreage by aquatic resource type (wetlands – forested and herbaceous, natural, or man-altered surface waters, upland-cut surface waters)

Please see RAI 1 – Table 2 – Completed Impact Acreage, attached below.

iv. the acreage of proposed impacts to all aquatic resources

Considering the approximate total of 314.59 acres of completed impacts to the aquatic resources, a remaining 425.86 acres of impacts to aquatic resources are currently proposed.

v. a breakdown of that proposed acreage by aquatic resource type (wetlands – forested and herbaceous, natural, or man-altered surface waters, upland-cut surface waters)

Please see RAI 1 – Table 3 – Remaining Impact Acreage, attached below.

b. the proposed construction duration for the proposed project (how long will you need the authorization under Section 404 to discharge dredged or fill material in waters of the United States?)

The proposed construction duration for the proposed project will be approximately 10 years.

3. Adjacent Property Owners:

Please provide a list of adjacent (contiguous) property owners, including the names and correct mailing addresses, for the distribution of the Public Notice. If there are over ten names (when the applicant and any authorized agent are included), please provide self-adhesive mailing labels for each name/address.

Attachment 4 – On-Site and Adjacent Parcels, as submitted in the permit application (page 182 of 391) to the USACE on January 2, 2025, is attached below.

For your convenience, please note that there are only 7 property owners for the 12 adjacent parcels, therefore no self-adhesive mailing labels are needed.

4. Overall Project Purpose:

Please provide a proposed overall project purpose. Information about defining a project's purpose and need is available in the SAJ's alternatives analysis memo (as Step 1), here:

https://usace.contentdm.oclc.org/utils/getfile/collection/p16021coll15/id/8122

The overall project purpose is to conduct heavy mineral mining operations within the Trail Ridge geological formation near Starke, Florida.

For addition information, please see the ESD included in the permit application submitted to the USACE on January 2, 2025. Section 1 of the ESD (page 6 of 391) includes a more detailed explanation of the project's purpose, while Section 3.3 (page 24 of 391) includes the Alternative Plan Analysis, which explains why the proposed location was chosen.

Sincerely,

Kristen Bell

Senior Project Manager

Enclosures:

Figure 1 – Location Map

Figure 10 – Mine Plan Map

Figures 11A – 11R – Wetland Impact Cross-Sections

Figure 11 – Wetland Impact Map

Table 2 – Wetlands and Surface Waters

Table 3 – Jurisdictional Wetlands Impact Summary

RAI 1 – Table 1 – Total Impact Acreage

RAI 1 – Table 2 – Completed Impact Acreage


RAI 1 – Table 3 – Remaining Impact Acreage

Attachment A – On-Site and Adjacent Parcels

APPENDIX A

Figures

Figure 1 – Location Map
Figure 10 – Mine Plan Map
Figures 11A – 11R – Wetland Impact Cross-Sections
Figure 11 – Wetland Impact Map

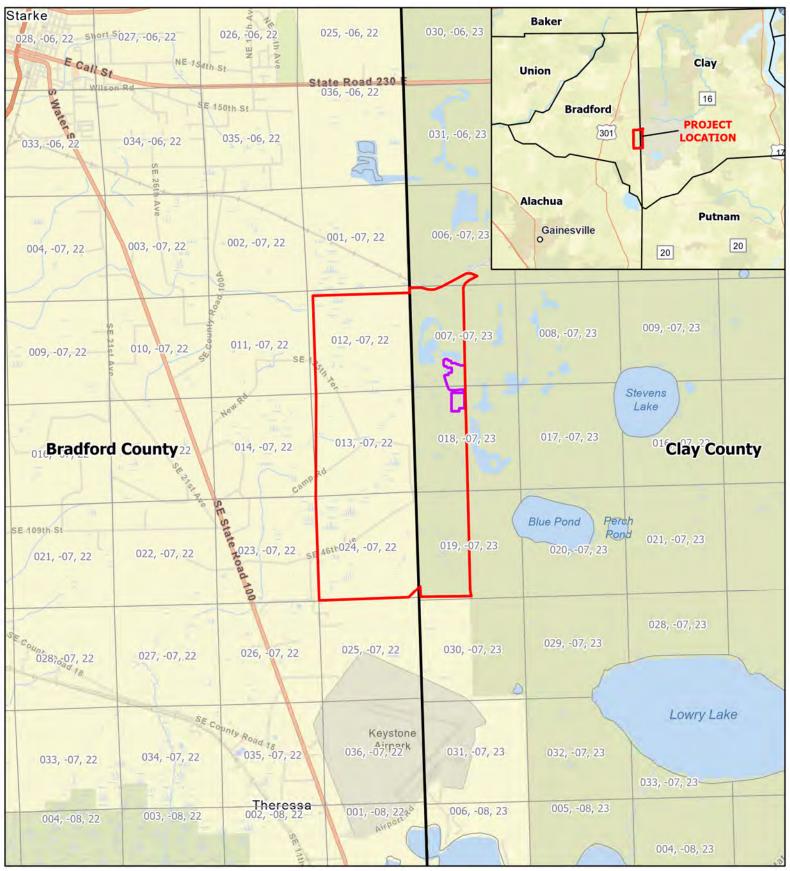



Mine Permit Boundary (± 2,884.4 Ac.)

Plant Site Boundary (± 44.1 Ac.)


Figure 1: Location Map


Trail Ridge South Mine 93087


The Chemours Company FC, LLC (29° 53' 7.22" N, 82° 3' 2.40" W)

Bradford and Clay Counties, Florida

Date: September 2024
Base map provided by
ESRI. Property boundary
provided by Chemours.

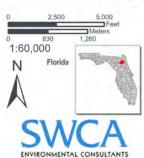

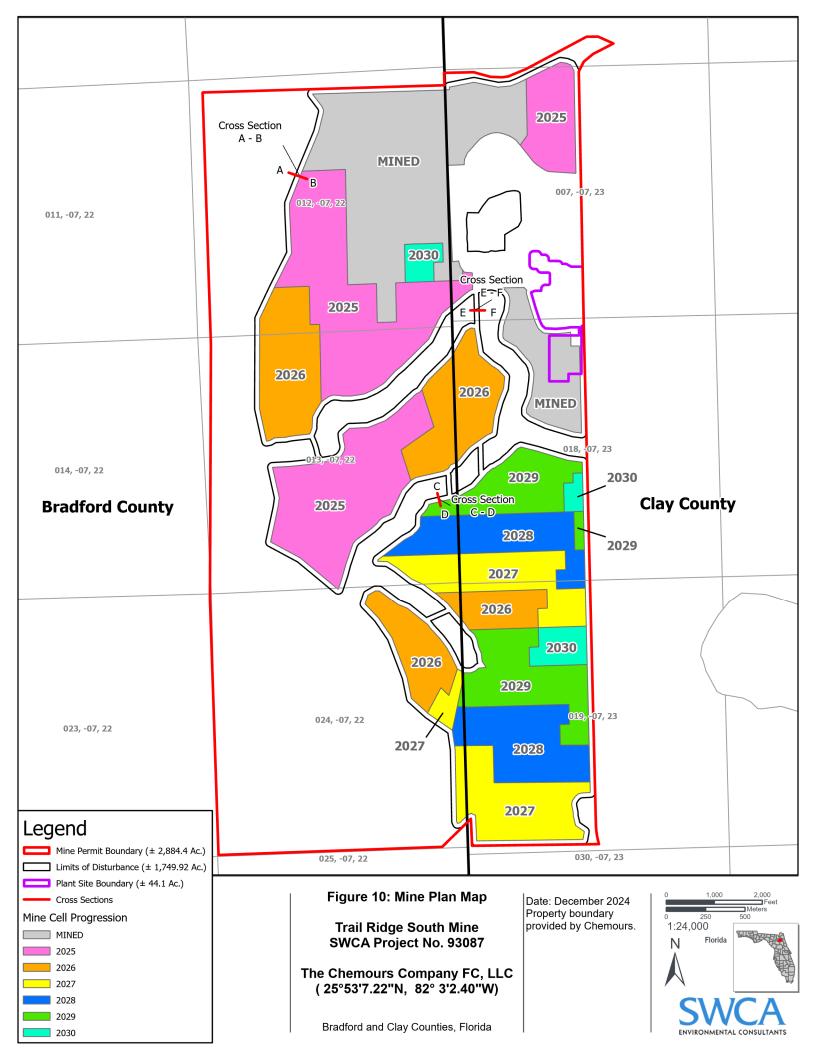

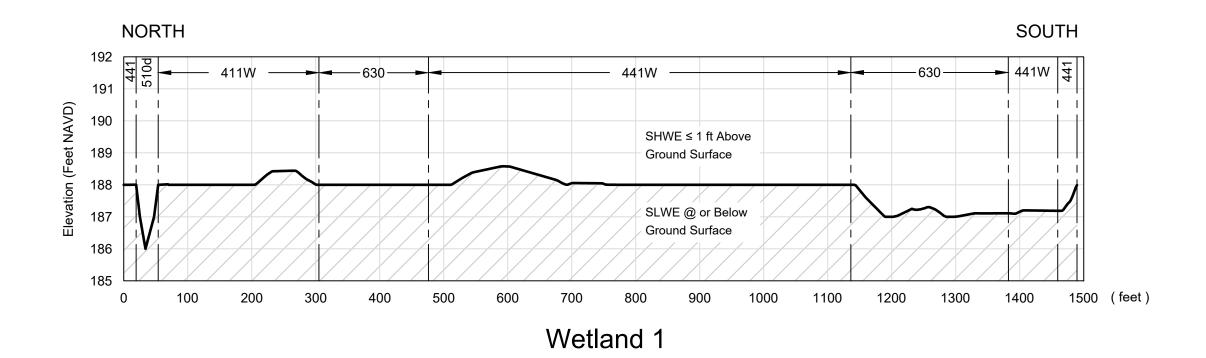

IMPACT

UNDISTURBED

EXISTING GROUND

----- LAND USE CODE

160 - Extractive

173 - Military

441 - Coniferous Plantation

441W- Coniferous Plantation Wetland

510d - Ditch/Canal


611 - Bay Swamps

630 - Wetland Forested Mixed

631 - Wetland Scrub

641 - Freshwater Marsh

8146- Primitive Roads/Trails

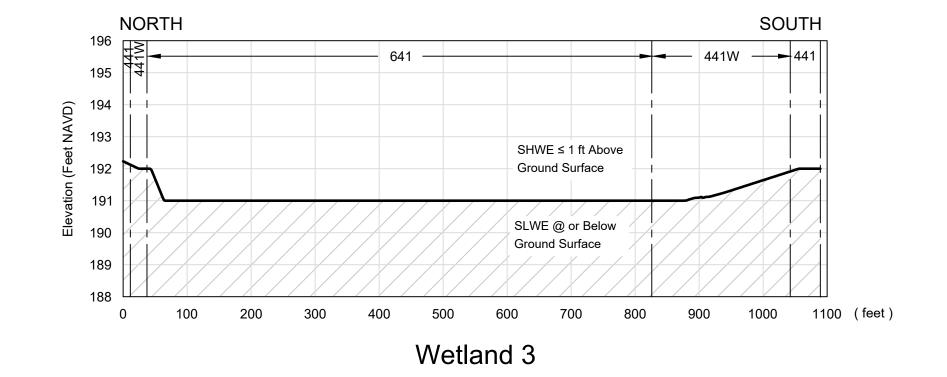

Source: Topography - Southern Resources

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SCALE: HORIZ. 1"= 150' VERT. 1"=3'



PROJECT NO	.00129491.003A	
DRAWN BY	YQ	
CHECKED BY	TRD	
DATE:	11-08-2019	

REVISED:


WETLAND IMPACT CROSS-SECTION WETLAND 1 & 3

Trail Ridge South The Chemours Company FC LLC Bradford and Clay Counties, FL

11A

FIGURE

PAGE:

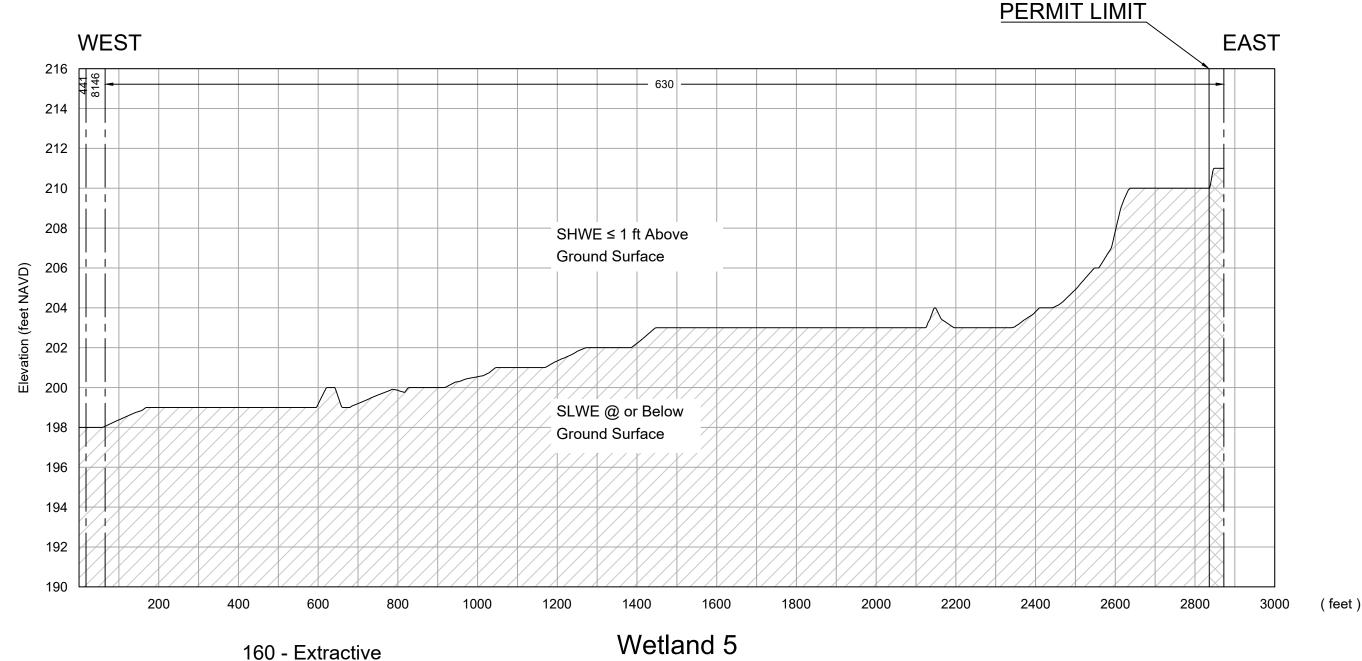

LEGEND 173 - Military

441 - Coniferous Plantation

IMPACT 441W- Coniferous Plantation Wetland

510d - Ditch/Canal

UNDISTURBED 611 - Bay Swamps

630 - Wetland Forested Mixed **EXISTING GROUND**

631 - Wetland Scrub 641 - Freshwater Marsh

LAND USE CODE 8146- Primitive Roads/Trails

SCALE: HORIZ. 1"= 100' VERT. 1"=5'



PROJECT NO.00129491.003A	WETLAND IMPACT CROSS-SECTION
DRAWN BY YQ	WETLAND 5
CHECKED BY TRD	Trail Ridge South
DATE: 11-08-2019	The Chemours Company FC LLC


FIGURE 11B

South The Chemours Company FC LLC Bradford and Clay Counties, FL

PAGE: 2 of 18

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IMPACT

UNDISTURBED

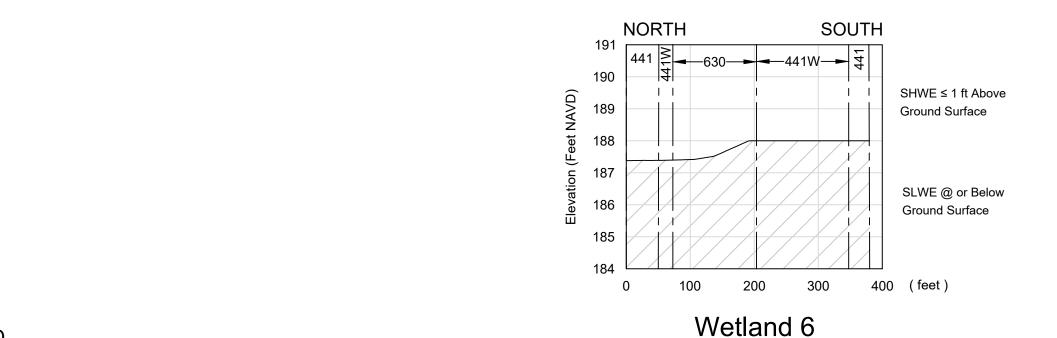EXISTING GROUND

----- LAND USE CODE

160 - Extractive

173 - Military

441 - Coniferous Plantation


441W- Coniferous Plantation Wetland

510d - Ditch/Canal

611 - Bay Swamps

630 - Wetland Forested Mixed



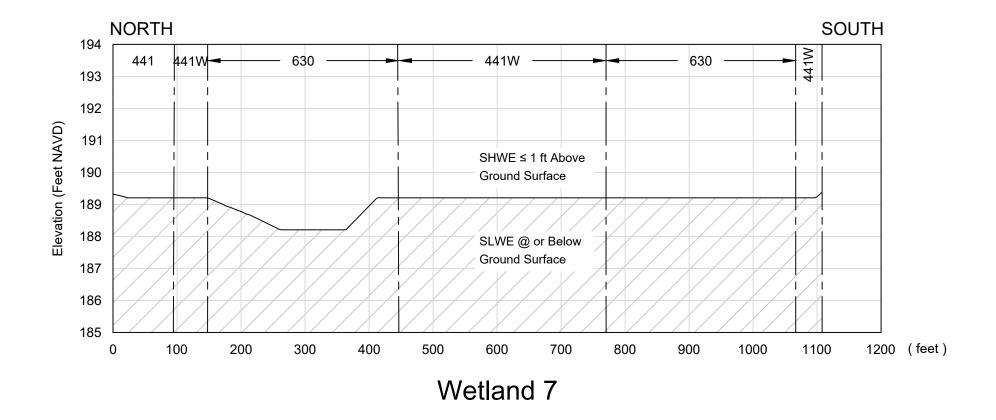

SCALE: HORIZ. 1"= 150' VERT. 1"=3"



PROJECT NO	.00129491.003A	١
DRAWN BY	YQ	
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DATE:	11-08-2019	

REVISED:

WETLAND IMPACT CROSS-SECTION WETLAND 6 & 7 Trail Ridge South

> The Chemours Company FC LLC Bradford and Clay Counties, FL

11C

FIGURE

PAGE: 3 of 18

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IMPACT

UNDISTURBED

EXISTING GROUND

----- LAND USE CODE

160 - Extractive

173 - Military

441 - Coniferous Plantation

441W- Coniferous Plantation Wetland

510d - Ditch/Canal

611 - Bay Swamps

630 - Wetland Forested Mixed


631 - Wetland Scrub

641 - Freshwater Marsh

8146- Primitive Roads/Trails

Source: Topography - Southern Resources Mapping, Inc. 2012.

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Wetland 8

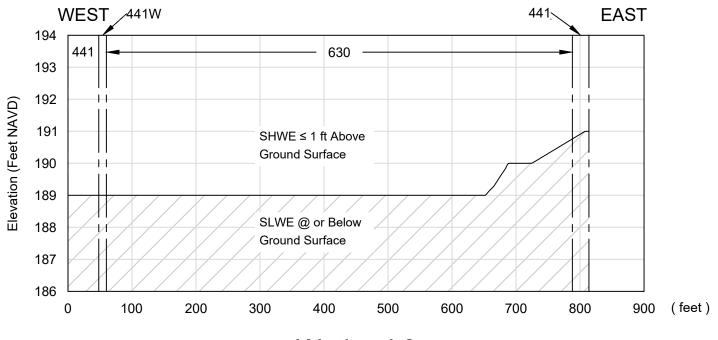SCALE: HORIZ. 1"= 150' VERT. 1"=3"



PROJECT NO.001294	191.003A	
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REVISED:

WETLAND IMPACT CROSS-SECTION WETLAND 8 Trail Ridge South DATE: 11-08-2019 The Chemours Company FC LLC

Bradford and Clay Counties, FL

FIGURE

11D

PAGE: 4 of 18

IMPACT

UNDISTURBED

EXISTING GROUND

----- LAND USE CODE

160 - Extractive

173 - Military

441 - Coniferous Plantation

441W- Coniferous Plantation Wetland

510d - Ditch/Canal

611 - Bay Swamps

630 - Wetland Forested Mixed


631 - Wetland Scrub

641 - Freshwater Marsh

8146- Primitive Roads/Trails

Source: Topography - Southern Resources Mapping, Inc. 2012.

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SCALE: HORIZ. 1"= 150' VERT. 1"=3'

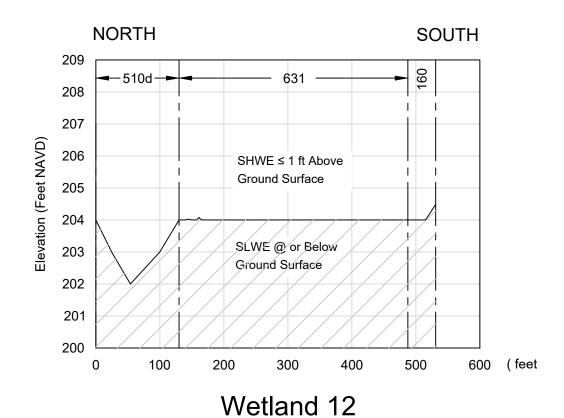

PROJECT NO.00129491.003A		WETLAND IMPACT CROSS-SECTION
DRAWN BY	YQ	WETLAND 12
CHECKED BY	TRD	Trail Ridge South

DDO IECT NO

DATE:

REVISED:

WETLAND 12 Trail Ridge South 11-08-2019 The Chemours Company FC LLC

Bradford and Clay Counties, FL

FIGURE

11E

PAGE: 5 of 18

IMPACT

----- LAND USE CODE

UNDISTURBED

EXISTING GROUND

441W- Coniferous Plantation Wetland


631 - Wetland Scrub


641 - Freshwater Marsh

8146- Primitive Roads/Trails

Source: Topography - Southern Resources Mapping, Inc. 2012.

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DATE: 11-08-2019
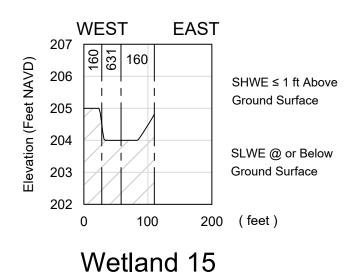
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WETLAND IMPACT CROSS-SECTION
WETLAND 15 & 16

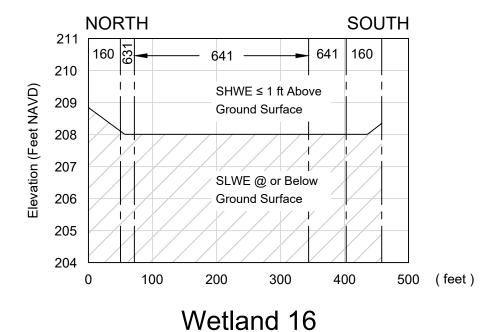Trail Ridge South
The Chemours Company FC LLC
Bradford and Clay Counties, FL

11F

FIGURE

PAGE: 6 of 18

160 - Extractive 173 - Military

441 - Coniferous Plantation

----- LAND USE CODE

IMPACT

UNDISTURBED

EXISTING GROUND

441W- Coniferous Plantation Wetland

510d - Ditch/Canal

611 - Bay Swamps

630 - Wetland Forested Mixed


631 - Wetland Scrub

641 - Freshwater Marsh

8146- Primitive Roads/Trails

Source: Topography - Southern Resources Mapping, Inc. 2012.

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PROJECT NO.00129491.003A WETLAND IMPACT CROSS-SECTION DRAWN BY YQ CHECKED BY TRD

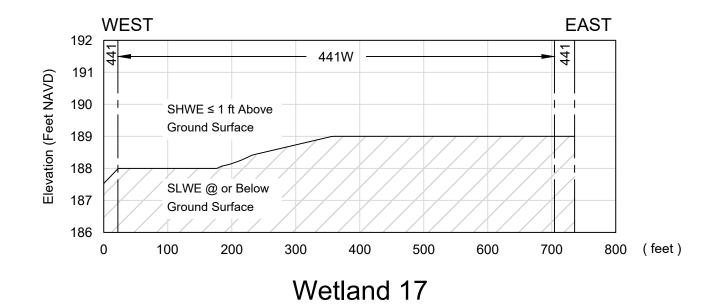11-08-2019

DATE:

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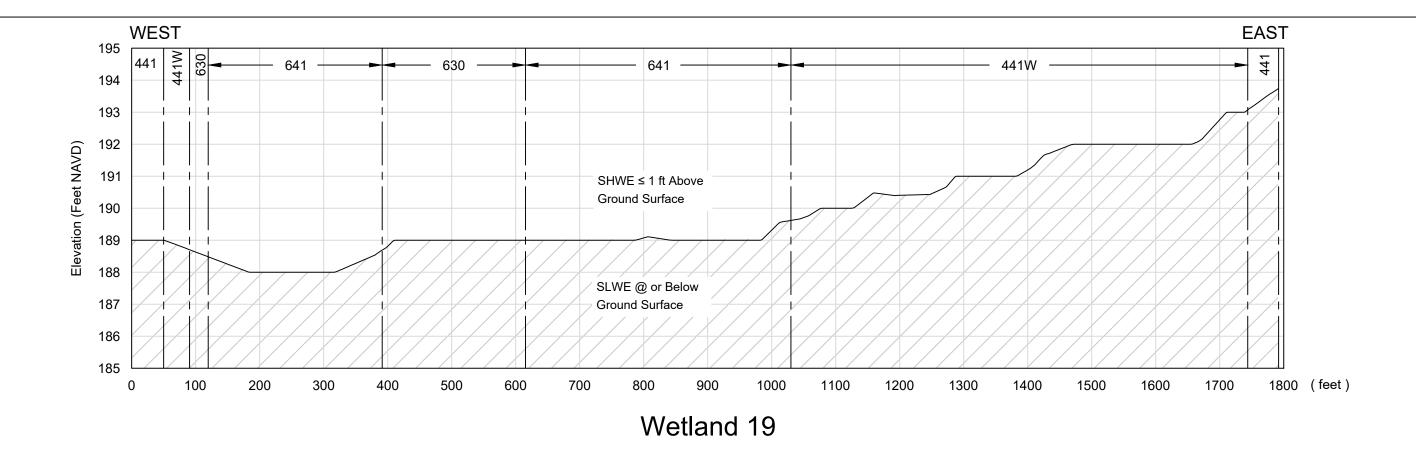
Trail Ridge South The Chemours Company FC LLC Bradford and Clay Counties, FL

WETLAND 17

FIGURE

11G

PAGE: 7 of 18



IMPACT

UNDISTURBED

EXISTING GROUND

----- LAND USE CODE

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160 - Extractive

173 - Military

441 - Coniferous Plantation

441W- Coniferous Plantation Wetland

510d - Ditch/Canal

611 - Bay Swamps

630 - Wetland Forested Mixed

631 - Wetland Scrub

641 - Freshwater Marsh

8146- Primitive Roads/Trails



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	DATE:	11-08-2019	

WETLAND IMPACT CROSS-SECTION WETLAND 19 Trail Ridge South

11H

FIGURE

The Chemours Company FC LLC Bradford and Clay Counties, FL

PAGE: 8 of 18

----- LAND USE CODE 160 - Extractive

173 - Military 441 - Coniferous Plantation 441W- Coniferous Plantation Wetland

510d - Ditch/Canal 611 - Bay Swamps

630 - Wetland Forested Mixed

IMPACT

UNDISTURBED


EXISTING GROUND

631 - Wetland Scrub

641 - Freshwater Marsh

8146- Primitive Roads/Trails

Source: Topography - Southern Resources Mapping, Inc. 2012.

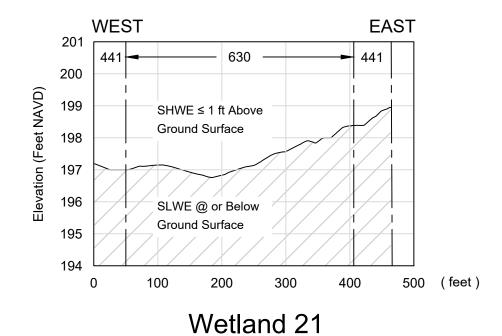

SCALE: HORIZ. 1"= 150' VERT. 1"=3'



PROJECT NO.00129491.003A DRAWN BY YQ CHECKED BY TRD DATE: 11-08-2019

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WETLAND IMPACT CROSS-SECTION WETLAND 21 Trail Ridge South

111

The Chemours Company FC LLC Bradford and Clay Counties, FL

FIGURE

PAGE: 9 of 18

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----- LAND USE CODE

160 - Extractive

173 - Military

441 - Coniferous Plantation

IMPACT

UNDISTURBED

EXISTING GROUND

441W- Coniferous Plantation Wetland

510d - Ditch/Canal

611 - Bay Swamps

630 - Wetland Forested Mixed


631 - Wetland Scrub

641 - Freshwater Marsh


8146- Primitive Roads/Trails

Source: Topography - Southern Resources Mapping, Inc. 2012.

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Wetland 24-1

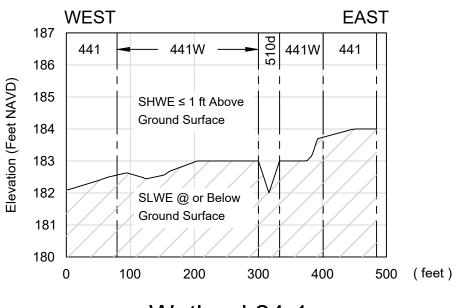

SCALE: HORIZ. 1"= 150' VERT. 1"=3"

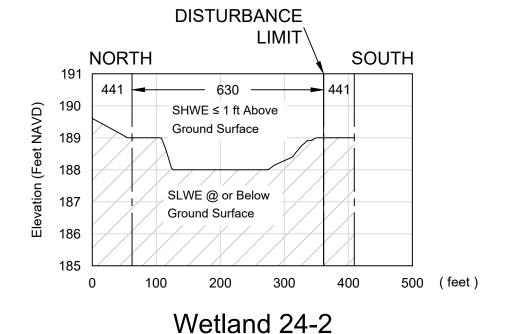

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	DATE:	11-08-2019	

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ETLAND IMPACT CROSS-SECTION WETLAND 24 Trail Ridge South

11J

FIGURE

The Chemours Company FC LLC Bradford and Clay Counties, FL

PAGE: 10 of 18

160 - Extractive 173 - Military

441 - Coniferous Plantation

----- LAND USE CODE

IMPACT

UNDISTURBED

EXISTING GROUND

441W- Coniferous Plantation Wetland

510d - Ditch/Canal

611 - Bay Swamps


630 - Wetland Forested Mixed


631 - Wetland Scrub


641 - Freshwater Marsh

8146- Primitive Roads/Trails

Source: Topography - Southern Resources Mapping, Inc. 2012.

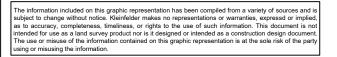

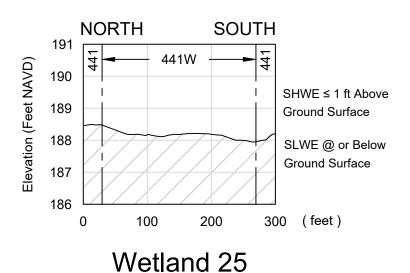

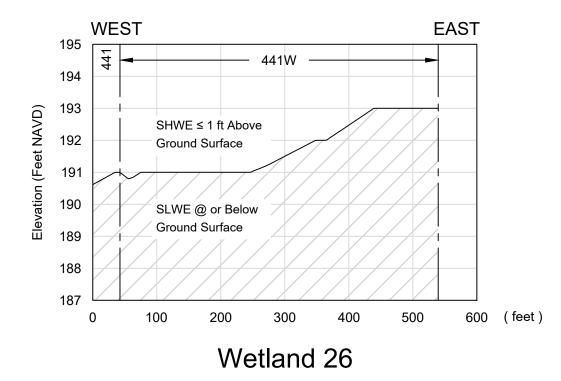

SCALE: HORIZ. 1"= 150' VERT. 1"=3"

KLEINFELDER Bright People. Right Solutions.

PROJECT NO.00129491.003A DRAWN BY YQ CHECKED BY TRD

11-08-2019

DATE:

REVISED:


WETLAND IMPACT CROSS-SECTION WETLAND 25 & 26

Trail Ridge South The Chemours Company FC LLC Bradford and Clay Counties, FL

FIGURE

11K

PAGE: 11 of 18

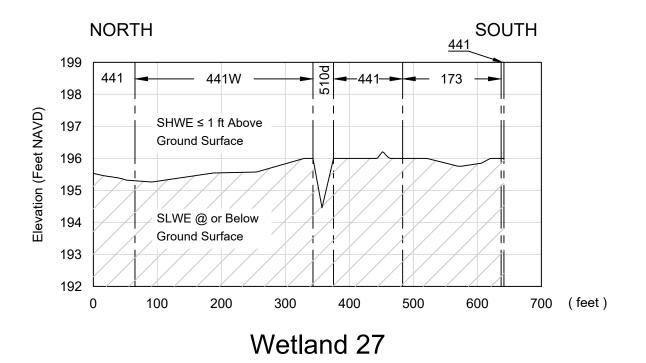

IMPACT

UNDISTURBED

EXISTING GROUND

----- LAND USE CODE

160 - Extractive

173 - Military

441 - Coniferous Plantation

441W- Coniferous Plantation Wetland

510d - Ditch/Canal

611 - Bay Swamps

630 - Wetland Forested Mixed


631 - Wetland Scrub

641 - Freshwater Marsh

8146- Primitive Roads/Trails

Source: Topography - Southern Resources Mapping, Inc. 2012.

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SCALE: HORIZ. 1"= 150' VERT. 1"=3"

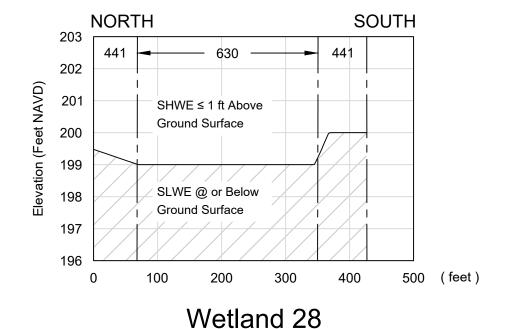

	PROJECT NO.001294	91.003A	
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)	CHECKED BY	TRD	

REVISED:

WETLAND IMPACT CROSS-SECTION WETLAND 27 & 28 DATE: 11-08-2019

Trail Ridge South The Chemours Company FC LLC Bradford and Clay Counties, FL

FIGURE

11L

PAGE: 12 of 18

630 - Wetland Forested Mixed

631 - Wetland Scrub

611 - Bay Swamps

641 - Freshwater Marsh

IMPACT


UNDISTURBED


EXISTING GROUND

8146- Primitive Roads/Trails

----- LAND USE CODE 160 - Extractive 173 - Military 441 - Coniferous Plantation 441W- Coniferous Plantation Wetland 510d - Ditch/Canal

Source: Topography - Southern Resources Mapping, Inc. 2012.

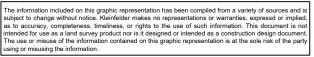

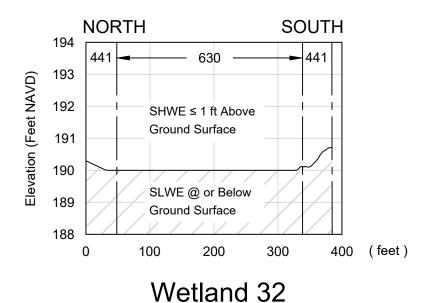

SCALE: HORIZ. 1"= 150'

VERT. 1"=3'



PROJECT NO	.00129491.003A	WE
DRAWN BY	YQ	
CHECKED BY	TRD	
DATE:	11-08-2019	

REVISED:

ETLAND IMPACT CROSS-SECTION WETLAND 32

11M

Trail Ridge South The Chemours Company FC LLC Bradford and Clay Counties, FL

PAGE: 13 of 18

FIGURE

WEST_510d **EAST** 190 189 SHWE ≤ 1 ft Above 188 **Ground Surface** Elevation (Feet NAVD) 187 186 SLWE @ or Below 184 **Ground Surface** 183 182 181 100 200 300 400 (feet) **LEGEND** Wetland 33 **IMPACT** ∕510d **EAST** WEST 197 **UNDISTURBED** 441 441W 196 **EXISTING GROUND** 195 194 160 - Extractive
173 - Military
441 - Coniferous Plantation
441W- Coniferous Plantation Wetland SHWE ≤ 1 ft Above ----- LAND USE CODE II II **Ground Surface** 193 192 191 SLWE @ or Below 190 **Ground Surface** 510d - Ditch/Canal 189 611 - Bay Swamps 188 630 - Wetland Forested Mixed 187 631 - Wetland Scrub 641 - Freshwater Marsh 186 8146- Primitive Roads/Trails 100 200 300 400 500 600 700 800 900 1000 1100 1200 1300 (feet) Wetland 34-1 Source: Topography - Southern Resources PROJECT NO.00129491.003A **FIGURE** WETLAND IMPACT CROSS-SECTION Mapping, Inc. 2012. DRAWN BY YQ WETLAND 33 & 34 SCALE: KLEINFELDER CHECKED BY TRD 11N The information included on this graphic representation has been compiled from a variety of sources and is subject to change without notice. Kleinfelder makes no representations or warranties, expressd or implied, as to accuracy, completeness, timeliness, or rights to the use of such information. This document is not intended for use as a land survey product nor is it designed or intended as a construction design document. The use or misuse of the information contained on this graphic representation is at the sole risk of the party using or misusing the information. Trail Ridge South HORIZ. 1"= 150' Bright People. Right Solutions. VERT. 1"=3" DATE: 11-08-2019 The Chemours Company FC LLC Bradford and Clay Counties, FL REVISED: PAGE: 14 of 18

160 - Extractive

173 - Military

441 - Coniferous Plantation

----- LAND USE CODE

IMPACT

UNDISTURBED

EXISTING GROUND

441W- Coniferous Plantation Wetland

510d - Ditch/Canal

611 - Bay Swamps

630 - Wetland Forested Mixed


631 - Wetland Scrub


641 - Freshwater Marsh

8146- Primitive Roads/Trails

Source: Topography - Southern Resources Mapping, Inc. 2012.

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SCALE: HORIZ. 1"= 150' VERT. 1"=3"
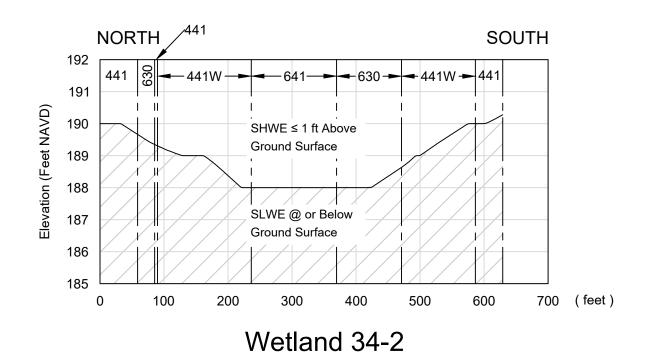
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ETLAND IMPACT CROSS-SECTION WETLAND 34 Trail Ridge South

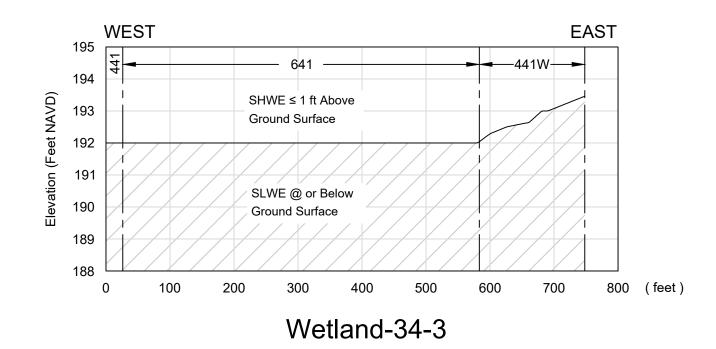Bradford and Clay Counties, FL

The Chemours Company FC LLC

110

PAGE: 15 of 18

FIGURE

441 - Coniferous Plantation

----- LAND USE CODE

IMPACT

UNDISTURBED

EXISTING GROUND

441W- Coniferous Plantation Wetland

510d - Ditch/Canal

611 - Bay Swamps

630 - Wetland Forested Mixed


631 - Wetland Scrub

641 - Freshwater Marsh


8146- Primitive Roads/Trails

Source: Topography - Southern Resources Mapping, Inc. 2012.

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Wetland 38 -1

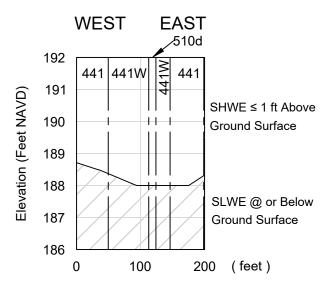

SCALE: HORIZ. 1"= 150' VERT. 1"=3"

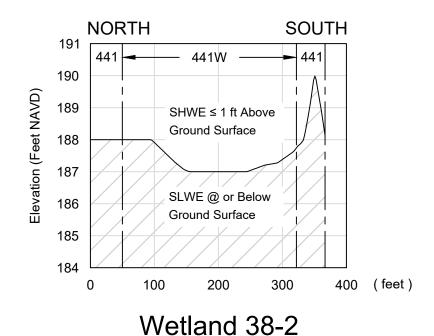

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ETLAND IMPACT CROSS-SECTION WETLAND 38 Trail Ridge South

Bradford and Clay Counties, FL

The Chemours Company FC LLC

FIGURE

11P

PAGE: 16 of 18

IMPACT

UNDISTURBED

EXISTING GROUND

----- LAND USE CODE

160 - Extractive

173 - Military

441 - Coniferous Plantation

441W- Coniferous Plantation Wetland

510d - Ditch/Canal

611 - Bay Swamps


630 - Wetland Forested Mixed


631 - Wetland Scrub

641 - Freshwater Marsh

8146- Primitive Roads/Trails

Source: Topography - Southern Resources Mapping, Inc. 2012.

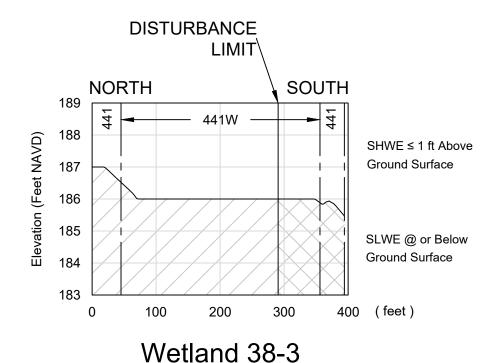

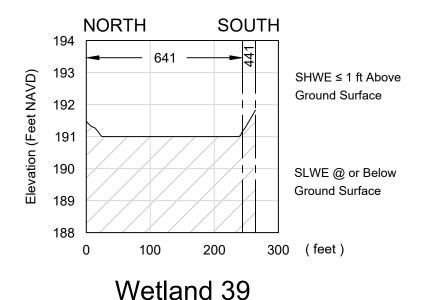

SCALE: KLEINFELDER HORIZ. 1"= 150' VERT. 1"=3"

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PROJECT NO.00129491.003A WETLAND IMPACT CROSS-SECTION DRAWN BY YQ WETLAND 38 & 39 CHECKED BY TRD

11-08-2019

Trail Ridge South The Chemours Company FC LLC Bradford and Clay Counties, FL

FIGURE

11Q

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630 - Wetland Forested Mixed

631 - Wetland Scrub

641 - Freshwater Marsh

IMPACT

----- LAND USE CODE

441 - Coniferous Plantation


UNDISTURBED

EXISTING GROUND

8146- Primitive Roads/Trails

Source: Topography - Southern Resources Mapping, Inc. 2012.

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SCALE: HORIZ. 1"= 150' VERT. 1"=3'

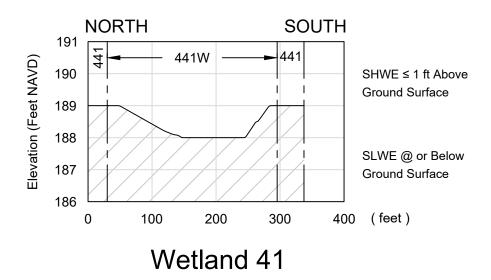

PROJECT NO	.00129491.003A	١
DRAWN BY	YQ	
CHECKED BY	TRD	
DATE:	11-08-2019	

REVISED:


WETLAND IMPACT CROSS-SECTION WETLAND 41

Trail Ridge South The Chemours Company FC LLC Bradford and Clay Counties, FL

11R

FIGURE


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Bradford and Clay Counties, Florida

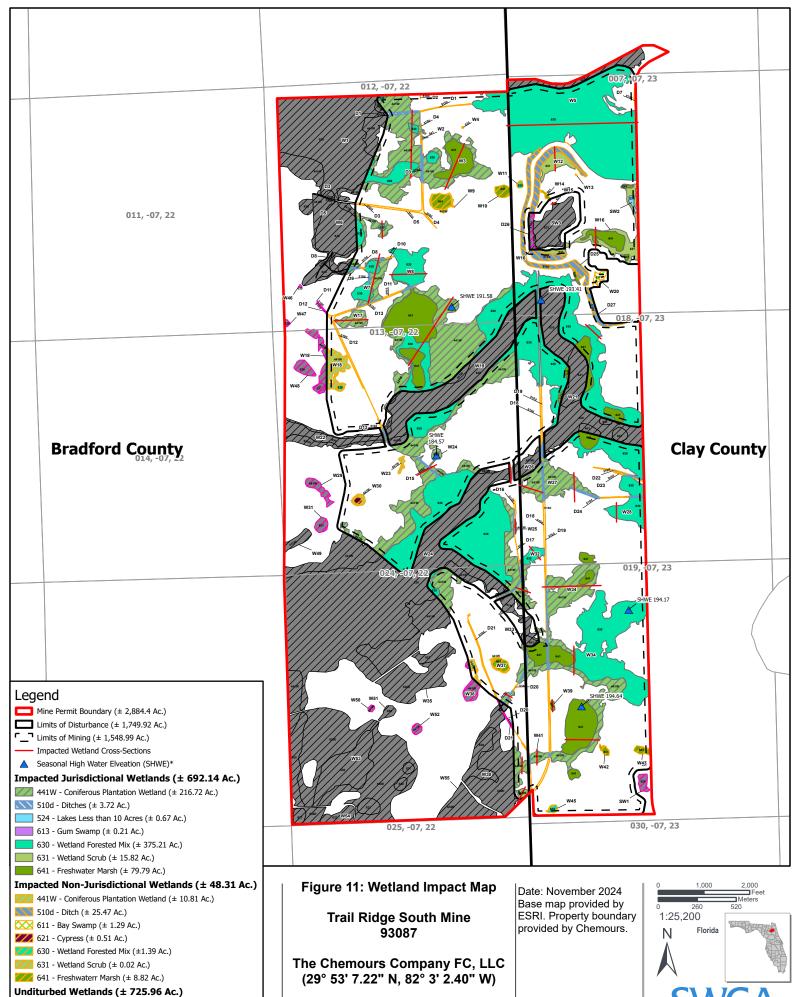Undisturbed Jurisdictional Wetlands (± 706.45 Ac.)

Undisturbed Non-Jurisdictional Wetlands (± 19.51 Ac.)



SAJ-2019-00480 -	Chemours	Trail Ridge	South Mine	Application –	Request for	Additional	Information	Response

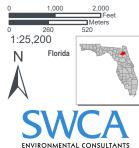APPENDIX B

Tables

Table 2 – Wetlands and Surface Waters Table 3 – Jurisdictional Wetlands Impact Summary

Table 2 Wetland and Surface Waters

	WL & SW ID	WL & SW TYPE	WL & SW SIZE	WL & SW NOT IMPACTED	TEMP	ORARY WL	. & SW	PERMANENT WL & SW IMPACTS			MITIGATION AREA ID
					WL & SW	IMPACT	IMPACT	WL & SW	IMPACT	IMPACT	
					TYPE	SIZE	CODE	TYPE	SIZE	CODE	
	W1	441W	48.19	19.54		28.65					MA 1 / Enhancement
	W1	630	84.21	76.32		7.89					MA 1 / Enhancement
	W2	641	0.10	0.00		0.10					MA1 / Enhancement
	W3	441W	12.85	0.00		12.85					MA 1
	W3	630	1.25	0.00		1.25					MA 1
	W3	641	8.89	0.00		8.89					MA 1
	W4	641	0.04	0.00		0.04					Isolated / Non-Jurisdictional - No Mitigation required
	W5	630	119.27	10.50		108.77					MA 1 / Enhancement
	W6	441W	13.29	9.04		4.25					MA 3 / Enhancement
	W6	630	28.08	25.58		2.50					MA 3 / Enhancement
	W7	441W	4.99	0.00		4.99					MA 1 / Enhancement
	W7	630	4.90	0.00		4.90					MA 1 / Enhancement
	W8	441W	0.41	0.00		0.41					MA 1 / Enhancement
	W8	630	11.02	0.00		11.02					MA 1 / Enhancement
	W9	441W	0.89	0.00		0.89					Isolated / Non-Jurisdictional - No Mitigation required
	W9	641	2.88	0.00		2.88					Isolated / Non-Jurisdictional - No Mitigation required
	W10	641	1.87	0.00		1.87					Isolated / Non-Jurisdictional - No Mitigation required
	W11	630	0.40	0.00		0.40					Isolated / Non-Jurisdictional - No Mitigation required
	W12	631	4.44	0.00		4.44					MA 1 / Enhancement
	W13	631	0.02	0.00		0.02					Isolated / Non-Jurisdictional - No Mitigation required
	W14	641	0.36	0.00		0.36					Isolated / Non-Jurisdictional - No Mitigation required
	W15	631	0.08	0.08		0.00					Undisturbed
	W16	631	12.57	1.19		11.38					MA 1 / Enhancement
	W16	641	5.61	0.00		5.61					MA 1 / Enhancement
	W17	441W	4.08	0.00		4.08					MA 4, 5, 6 / Enhancement
	W18	441W	10.23	3.66		6.57					Isolated / Non-Jurisdictional - No Mitigation required
	W18	630	0.29	0.00		0.29					Isolated / Non-Jurisdictional - No Mitigation required
	W18	621	0.29	0.84		0.29					Undisturbed
	W19	441W	63.03	4.54		58.49					MA 1 / Enhancement
	W19		92.11								
	W19	630	26.42	43.60 0.00		48.51					MA 1 / Enhancement
	W19 W20	641				26.42					MA 1 / Enhancement
		611	1.29	0.00		1.29					Isolated / Non-Jurisdictional - No Mitigation required
	W21	630	98.32	37.81		60.51					MA 1 and 12 / Enhancement
	W21	641	25.57	14.77		10.80					MA 1 / Enhancement
	W22	441W	6.70	6.60		0.10					MA 11 / Enhancement
	W22	630	8.48	8.37		0.11					MA 11 / Enhancement
	W23	441W	0.67	0.00		0.67					Isolated / Non-Jurisdictional - No Mitigation required
	W24	441W	89.37	53.42		35.95					MA 1 and 7 / Enhancement
	W24	613	0.21	0.00		0.21					MA 7 / Enhancement
	W24	630	241.56	172.82		68.74					MA 1 and 7 / Enhancement
	W25	441W	0.23	0.00		0.23					MA 1 / Enhancement
	W26	441W	10.89	4.74		6.15					MA 1 / Enhancement
	W27	441W	9.82	0.00		9.82					MA 1 / Enhancement
	W28	630	11.82	0.00		11.82					MA 1 / Enhancement
	W29	441W	2.73	2.73							Undisturbed
	W30	441W	0.87	0.00		0.87					Isolated / Non-Jurisdictional - No Mitigation required
	W30	621	0.51	0.00		0.51					Isolated / Non-Jurisdictional - No Mitigation required
	W31	621	1.67	1.67							Undisturbed
	W32	630	2.77	0.00		2.77					MA 1 / Enhancement
	W33	441W	15.28	5.33		9.95					MA 1 / Enhancement
	W33	641	5.13	1.11		4.02					MA 1 / Enhancement
	W34	441W	33.48	0.00		33.48					MA 1 / Enhancement
	W34	630	46.42	0.00		46.42					MA 1 / Enhancement
	W34	641	23.52	0.00		23.52					MA 1 / Enhancement
	W35	441W	20.48	20.48							Undisturbed
	W35	621	4.12	4.12							Undisturbed
	W36	441W	4.33	3.04		1.29					Isolated / Non-Jurisdictional - No Mitigation required
	W37	441W	0.52	0.00		0.52					Isolated / Non-Jurisdictional - No Mitigation required
	W37	641	1.82	0.00		1.82					Isolated / Non-Jurisdictional - No Mitigation required
	W38	441W	34.13	28.53		5.60					MA 1 / Enhancement
	W38	630	8.33	8.33							Undisturbed
	W39	641	0.43	0.00		0.43					MA 9 / Enhancement
	W41	441W	1.72	0.00		1.72					MA 1 / Enhancement
—	W42	641	0.70	0.00		0.70					Isolated / Non-Jurisdictional - No Mitigation required
—	W43	641	1.16	0.00		1.16					Isolated / Non-Jurisdictional - No Mitigation required
<u> </u>	VV +-3	041	1.10	0.00		1.10	<u> </u>	L	L		isolated / Norr-surisdictional - No Mittgation required

Table 2 Wetland and Surface Waters

WL & SW ID	WL & SW TYPE	WL & SW SIZE	WL & SW NOT IMPACTED	ТЕМР	ORARY WI	& SW	PERM	ANENT WI		MITIGATION AREA ID
				WL & SW			WL & SW		IMPACT	
				TYPE	SIZE	CODE	TYPE	SIZE	CODE	
W45	630	0.69	0.00		0.69					Isolated / Non-Jurisdictional - No Mitigation requi
W46	630	0.06	0.06							Undisturbed
W47	630	0.33	0.33							Undisturbed
W48	630	2.34	2.34							Undisturbed
W49	441W	2.79	2.79							Undisturbed
W50	441W	0.37	0.37							Undisturbed
W51	630	1.48	1.48							Undisturbed
W52	441W	0.94	0.94							Undisturbed
W53	441W	72.26	72.26							Undisturbed
W53	621	4.30	4.30							Undisturbed
W53	630	33.38	33.38							Undisturbed
W54	441W	3.67	3.67							Undisturbed
W54	621	5.92	5.92							Undisturbed
W55	441W	11.55	11.55							Undisturbed
SW1	524	1.60	1.60		0.07					Undisturbed
SW2	524	0.67	0.00		0.67					Enhancement Lindisturbed
SW3	523	13.65	13.65		0.40				 	Undisturbed
D1	510d	0.43	0.00		0.43				<u> </u>	Upland Cut Ditch - No Mitigation required
D1	510d	0.77	0.08	<u> </u>	0.69					Wetland Cut Ditch - Enhancement
D2	510d	0.005	0.00		0.005				<u> </u>	Upland Cut Ditch - No Mitigation required
D3	510d	0.34	0.00		0.34				<u> </u>	Upland Cut Ditch - No Mitigation required
D3	510d	0.14	0.03		0.11					Wetland Cut Ditch - Enhancement
D4	510d	0.13	0.00		0.13					Upland Cut Ditch - No Mitigation required
D4	510d	0.12	0.00		0.12					Wetland Cut Ditch - Enhancement
D5	510d	0.17	0.00		0.17					Upland Cut Ditch - No Mitigation required
D5	510d	0.05	0.05		0.04					Wetland Cut Ditch - Undisturbed
D6	510d	0.01	0.00		0.01					Upland Cut Ditch - No Mitigation required
D7	510d	0.08	0.00		0.08					Upland Cut Ditch - No Mitigation required
D8	510d	0.08	0.00		0.08					Upland Cut Ditch - No Mitigation required
D8	510d	0.41	0.29		0.12					Wetland Cut Ditch - Enhancement
D9 D10	510d	0.13	0.00		0.13					Wetland Cut Ditch - Enhancement
	510d	0.11	0.00		0.11					Upland Cut Ditch - No Mitigation required
D10 D11	510d 510d	0.07 0.11	0.00		0.07					Wetland Cut Ditch - Enhancement
		0.11								Upland Cut Ditch - No Mitigation required
D11 D12	510d	0.09	0.01		0.08					Wetland Cut Ditch - Enhancement
D12	510d 510d	0.001	0.001		0.14					Upland Cut Ditch - No Mitigation required
D12	510d	0.38	0.001		0.38					Wetland Cut Ditch - Undisturbed Upland Cut Ditch - No Mitigation required
D13	510d	0.05	0.00		0.05					Wetland Cut Ditch - Enhancement
D13	510d	0.03	0.00		0.03					Upland Cut Ditch - No Mitigation required
D14	510d	0.0002	0.00		0.0002					Wetland Cut Ditch - Enhancement
D15	510d	0.36	0.00		0.36					Wetland Cut Ditch - Enhancement
D16	510d	0.02	0.00		0.02					Upland Cut Ditch - No Mitigation required
D16	510d	0.02	0.00		0.02					Wetland Cut Ditch - Enhancement
D17	510d	0.01	0.00		0.01					Upland Cut Ditch - No Mitigation required
D17	510d	0.10	0.00		0.04					Wetland Cut Ditch - Enhancement
D18	510d	0.65	0.00		0.10					Upland Cut Ditch - No Mitigation required
D18	510d	0.05	0.00		0.05					Wetland Cut Ditch - Enhancement
D19	510d	0.13	0.00		0.13					Upland Cut Ditch - No Mitigation required
D19	510d	0.29	0.00		0.29					Wetland Cut Ditch - Enhancement
D20	510d	0.32	0.00		0.32				\vdash	Upland Cut Ditch - No Mitigation required
D20	510d	0.29	0.04		0.23					Wetland Cut Ditch - Enhancement
D21	510d	0.09	0.03		0.06					Upland Cut Ditch - No Mitigation required
D21	510d	0.03	0.03		0.00					Wetland Cut Ditch - Enhancement
D22	510d	0.51	0.00		0.51					Upland Cut Ditch - No Mitigation required
D22	510d	0.13	0.00		0.13					Wetland Cut Ditch - Enhancement
D23	510d	0.13	0.00		0.03					Upland Cut Ditch - No Mitigation required
D23	510d	0.04	0.00		0.03				╁──┤	Wetland Cut Ditch - Enhancement
D23	510d	0.01	0.00		0.01				\vdash	Upland Cut Ditch - No Mitigation required
D24	510d 510d	0.32	0.00		0.32					Wetland Cut Ditch - No Mitigation required
D24 D25	510d	9.32	0.00		9.32					Upland Cut Ditch - Enhancement Upland Cut Ditch - No Mitigation required
D25	510d 510d	11.22	1.80		9.32					Upland Cut Ditch - No Mitigation required
D26 D27	510d	2.58	0.00		2.58				 	Upland Cut Ditch - No Mitigation required Upland Cut Ditch - No Mitigation required
TOTALS	3100	1466.41	725.96		740.45			0.00		Opiana Out Diton - No Willigation required
JURISDICTIONAL TOTALS		1398.59	706.45		692.14			0.00		
		1000.03	100.40		002.14			0.00		

Wetland Type: from an established wetland classification system Impact Type: D=dredge; F=Fill; H=change hydrology; S=shading; C=clearing; O=other

Table 3
Jurisdictional Wetland Impact Summary

	Cuonar Wetland III	<u> </u>	TOTAL IMPACTS
WETLAND ID	LAND USE	TOTAL (Ac)	(Ac)
W1	441W	48.19	28.65
W1	630	84.21	7.89
W2	641	0.10	0.10
W3	441W	12.85	12.85
W3	630	1.25	1.25
W3	641	8.89	8.89
W5	630	119.27	108.77
W6	441W	13.29	4.25
W6	630	28.08	2.50
W7	441W	4.99	4.99
W7	630	4.90	4.90
W8	441W	0.41	0.41
W8	630	11.02	11.02
W12	631	4.44	4.44
W16	631	12.57	11.38
W16	641	5.61	5.61
W17	441W	4.08	4.08
W19	441W	63.03	58.49
W19	630	92.11	48.51
W19	641	26.42	26.42
W21	630	98.32	60.51
W21	641	25.57	10.80
W22	441W	6.70	0.10
W22	630	8.48	0.11
W24	441W	89.37	35.95
W24	613	0.21	0.21
W24	630	241.56	68.74
W25	441W	0.23	0.23
W26	441W	10.89	6.15
W27	441W	9.82	9.82
W28	630	11.82	11.82
W32	630	2.77	2.77
W33	441W	15.28	9.95
W33	641	5.13	4.02
W34	441W	33.48	33.48
W34	630	46.42	46.42
W34	641	23.52	23.52
W38	441W	34.13	5.60
W39	641	0.43	0.43
W41	441W	1.72	1.72
SW2	524	0.67	0.67
D1	510d	0.77	0.69
D3	510d	0.14	0.11
D4	510d	0.12	0.12
D8	510d	0.41	0.12
D9	510d	0.13	0.13
D10	510d	0.07	0.07
D11	510d	0.09	0.08
D13	510d	0.05	0.05
D14	510d	0.0002	0.0002
D15	510d	0.36	0.36
D16	510d	0.01	0.01
D17	510d	0.10	0.10
D18	510d	0.15	0.15
D19	510d	0.32	0.32
D20	510d	0.68	0.54
D21	510d	0.04	0.01
D22	510d	0.13	0.13
D23	510d	0.01	0.01
D24	510d	0.72	0.72
	NAL WETLAND IMPACTS TOTAL		1
JURISDICTION	NAL WETLAND IMPACTS TOTAL	1216.53	692.14

APPENDIX C

RAI 1 Tables

RAI 1 – Table 1 – Total Impact Acreage RAI 1 – Table 2 – Completed Impact Acreage RAI 1 – Table 3 – Remaining Impact Acreage

RAI 1 - Table 1: Total Impact Acreage

Aquatic Resource Type	FLUCFCS CODES	JURISDICTIONAL	TOTAL IMPACT ACREAGE					
Wetlands - Forested and Herbacious	441W, 613, 630, 631, 641	Yes	687.75					
Wellanus - Foresteu and Herbacious	441W, 611, 621, 630, 631, 641	No	22.84					
Natural Curtago Waters	524	Yes	0.67					
Natural Surface Waters	524	No	0.00					
Man-Altered Surface Waters	F10d (Motland Cut Ditabas)	Yes	3.72					
Man-Altered Surface Waters	510d (Wetland-Cut Ditches)	No	0.00					
Unland Cut Surface Waters	F10d (Upland Cut Ditabas)	Yes	0.00					
Upland-Cut Surface Waters	510d (Upland-Cut Ditches)	No	25.47					
		692.14						
		48.31						
		Aquatic Resource Total	740.45					

RAI 1 - Table 2: Completed Impact Acreage

Aquatic Resource Type	FLUCFCS CODES	APPROXIMATE IMPACTS COMPLETED AS OF MARCH 2025		
Wetlands - Forested and Herbacious	441W, 630, 641	309.06		
Natural Surface Waters	524	0.00		
Man-Altered Surface Waters	510d (Wetland-Cut Ditches)	1.11		
Upland-Cut Surface Waters	510d (Upland-Cut Ditches)	4.42		
	Total	314.59		

RAI 1 - Table 3: Remaining Impact Acreage

Aquatic Resource Type	FLUCFCS CODES	APPROXIMATE IMPACTS REMAINING AS OF MARCH 2025		
Wetlands - Forested and Herbacious	441W, 611, 621 613, 630, 631, 641	401.53		
Natural Surface Waters	524	0.67		
Man-Altered Surface Waters	510d (Wetland-Cut Ditches)	2.61		
Upland-Cut Surface Waters	510d (Upland-Cut Ditches)	21.05		
	Total	425.86		

SAJ-2019-00480 - Chemours Trail Ridge South Mine Application – Request for Additional Information Response
ATTACHMENT A
On-Site and Adjacent Parcels

Attachment 4 On-Site and Adjacent Parcels

Parcel ID	Property Owner Name	Address	Zip Code	County	Acreage
19-07-23-000732-000-00	Armory Board State Of FL	C/O Dept Of Mil Affairs/State Camp Blanding Lands, 82 Marine St, Saint Augustine, FL	320845039	Clay	638.00
18-07-23-000731-017-00	Armory Board State Of FL	C/O Dept Of Mil Affairs/State Camp Blanding Lands, 82 Marine St, Saint Augustine, FL	320845039	Clay	638.00
07-07-23-000731-006-00	Armory Board State Of FL	C/O Dept Of Mil Affairs/State Camp Blanding Lands, 82 Marine St, Saint Augustine, FL	320845039	Clay	638.00
06-07-23-00731-005-00	Armory Board State Of FL	C/O Dept Of Mil Affairs/State Camp Blanding Lands, 82 Marine St, Saint Augustine, FL	320845039	Clay	637.00
04828-0-00000	Suwanee River Water Management District	9225 CR 49, Live Oak, FL	32060	Bradford	632.11
04829-0-00000	Suwanee River Water Management District	9225 CR 49, Live Oak, FL	32060	Bradford	835.00
04986-0-00000	Suwanee River Water Management District	9225 CR 49, Live Oak, FL	32060	Bradford	639.00
30-07-23-000741-000-00	City Of Keystone Heights	Airport 7100 Airport Rd, Starke, FL	32091	Clay	14.54
30-07-23-000740-000-00	Armory Board State Of FL	C/O Dept Of Mil Affairs/State Camp Blanding Lands, 82 Marine St, Saint Augustine, FL	320845039	Clay	14.54
04818-0-00000	Rayonier Tax Services	PO BOX 161139, Mobile, AL	36616	Bradford	546.75
04831-0-00000	Rayonier Tax Services	PO BOX 161139, Mobile, AL	36616	Bradford	605.00
04985-0-00000	Rayonier Tax Services	PO BOX 161139, Mobile, AL	36616	Bradford	634.75
04612-0-00100 10	North Florida Land Trust	2038 GILMORE ST, JACKSONVILLE, FL	32204	Bradford	227.00
04613-0-00000 10	North Florida Land Trust	2039 GILMORE ST, JACKSONVILLE, FL	32204	Bradford	402.27
04993-0-00100 HX H3	Baldree, Robert & Linda	1404 SE 101ST WAY, STARKE, FL	320919348	Bradford	40.00
04991-0-00200	Munen, Delano Lex	8286 SE 11th Ave, Starke, FL	32091	Bradford	12.60
04991-0-00201	Munen, Delano Lex	8286 SE 11th Ave, Starke, FL	32091	Bradford	5.00
04989-0-00000 05	Suwanee River Water Management District	9225 CR 49, Live Oak, FL	32060	Bradford	107.49
04987-0-00000 04	City Of Keystone Heights	Airport 7100 Airport Rd, Starke, FL	32091	Bradford	250.00
	= On-site parcel				